


# OLD McGREGOR ROAD PUMP STATION

CITY OF WACO , TEXAS


APRIL 1986

WILLIAM A. JOHNSON  
CONSULTING ENGINEER  
WACO , TEXAS

GLENN L. DRENNON ASSOCIATES  
CONSULTING ENGINEER  
WACO , TEXAS

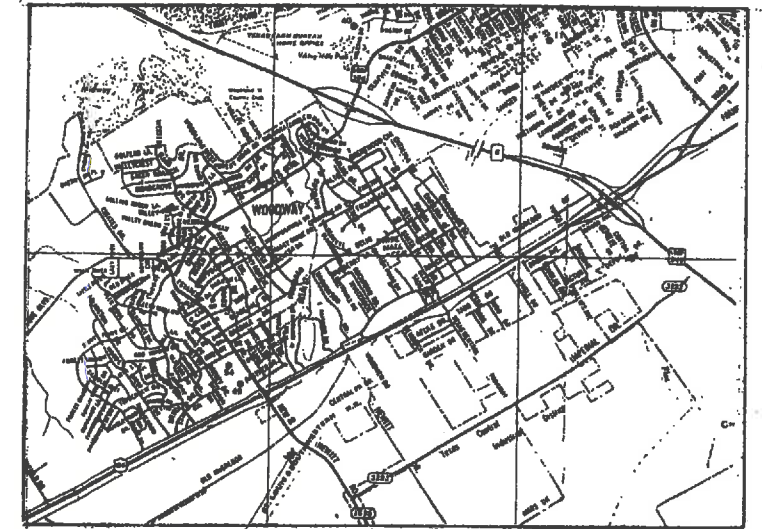

JOB LOCATION  
 NEIGHBORLY MAP  
 TO SCALE

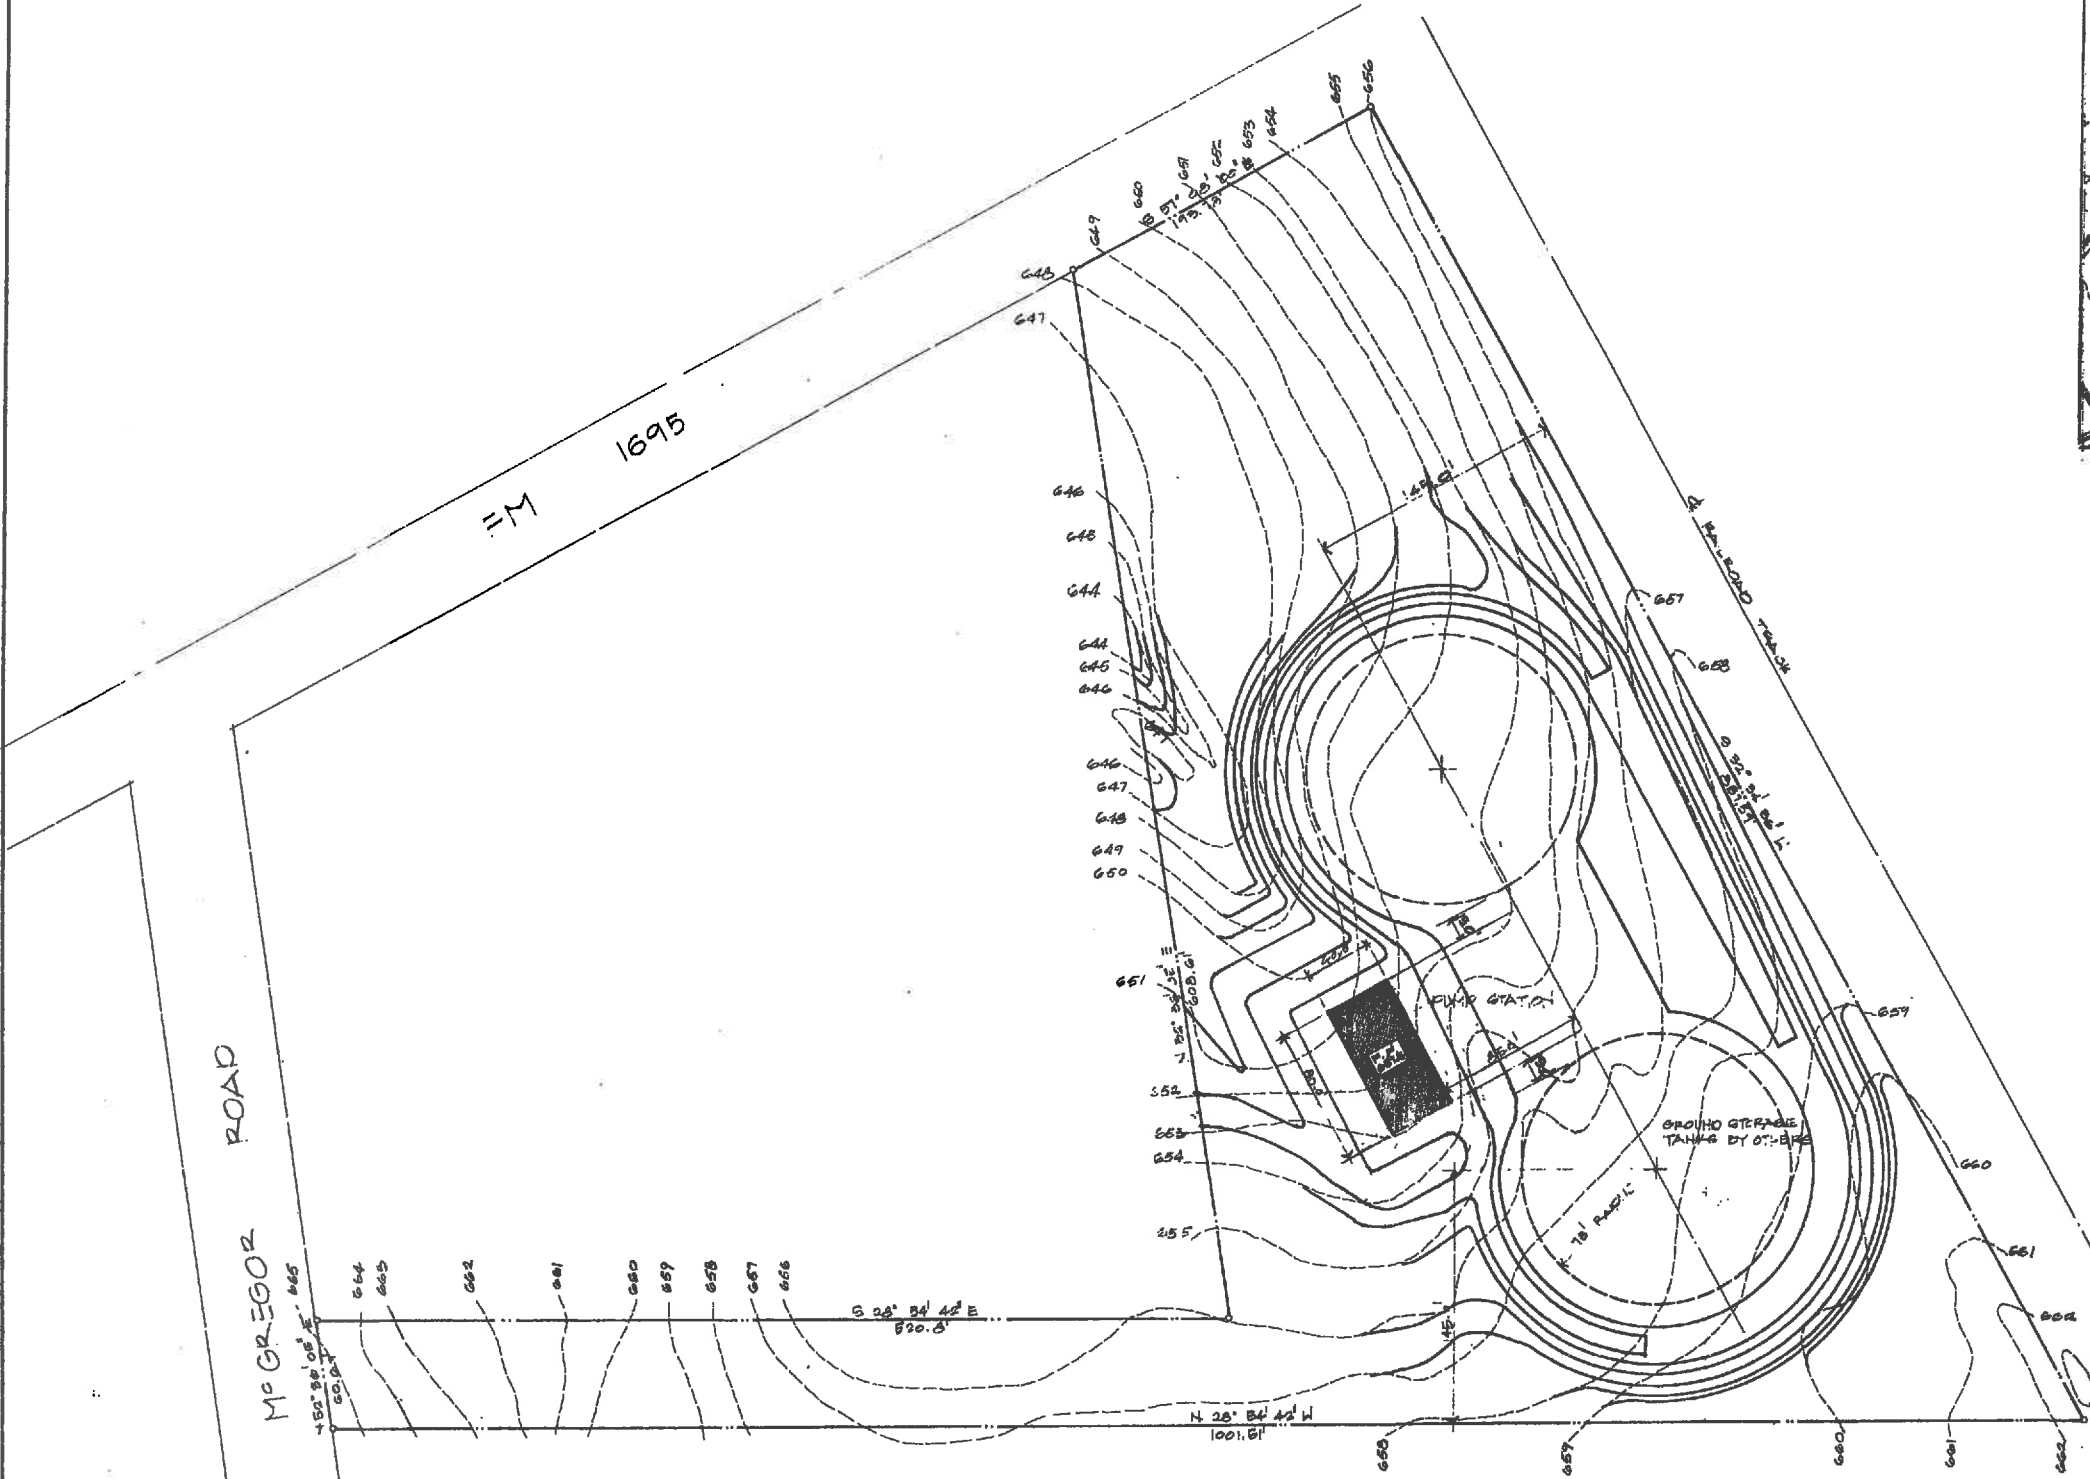

**SITE PLAN**  
 SCALE 1"=50'


**LEGEND**  
 ——— EXISTING CONTOURS  
 - - - - - NEW CONTOURS

ALL SITE GRADING TO BE BY THE CITY OF WACO. BUILDING FILL BY GENERAL CONTRACTOR.

NOTE: VERIFY FINISH CONTOURS W/ FINAL GRADING OF SURROUNDING PLATS

		CITY OF WACO		TEXAS
		WACO, TEXAS	DATE: FEB. 10, 1998	SCALE: AS NOTED
WM. A. JOHNSON CONSULTING ENGINEER WACO, TEXAS		OLD Mc GREGOR ROAD PUMP STATION		
				<b>51</b>




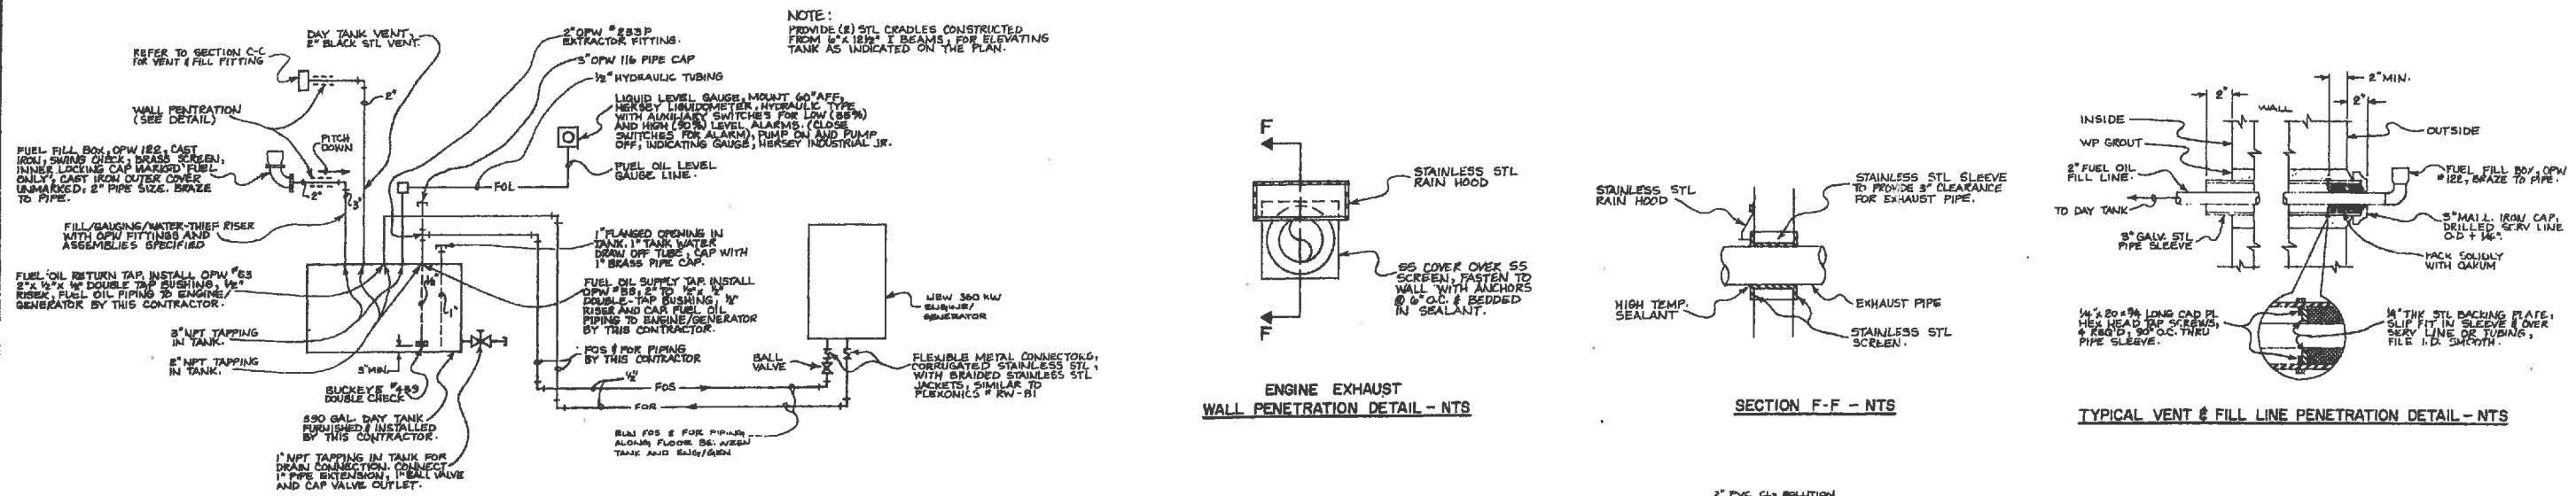



**ENGINE EXHAUST WALL PENETRATION DETAIL - NTS**

**SECTION F-F - NTS**



**TYPICAL VENT & FILL LINE PENETRATION DETAIL - NTS**

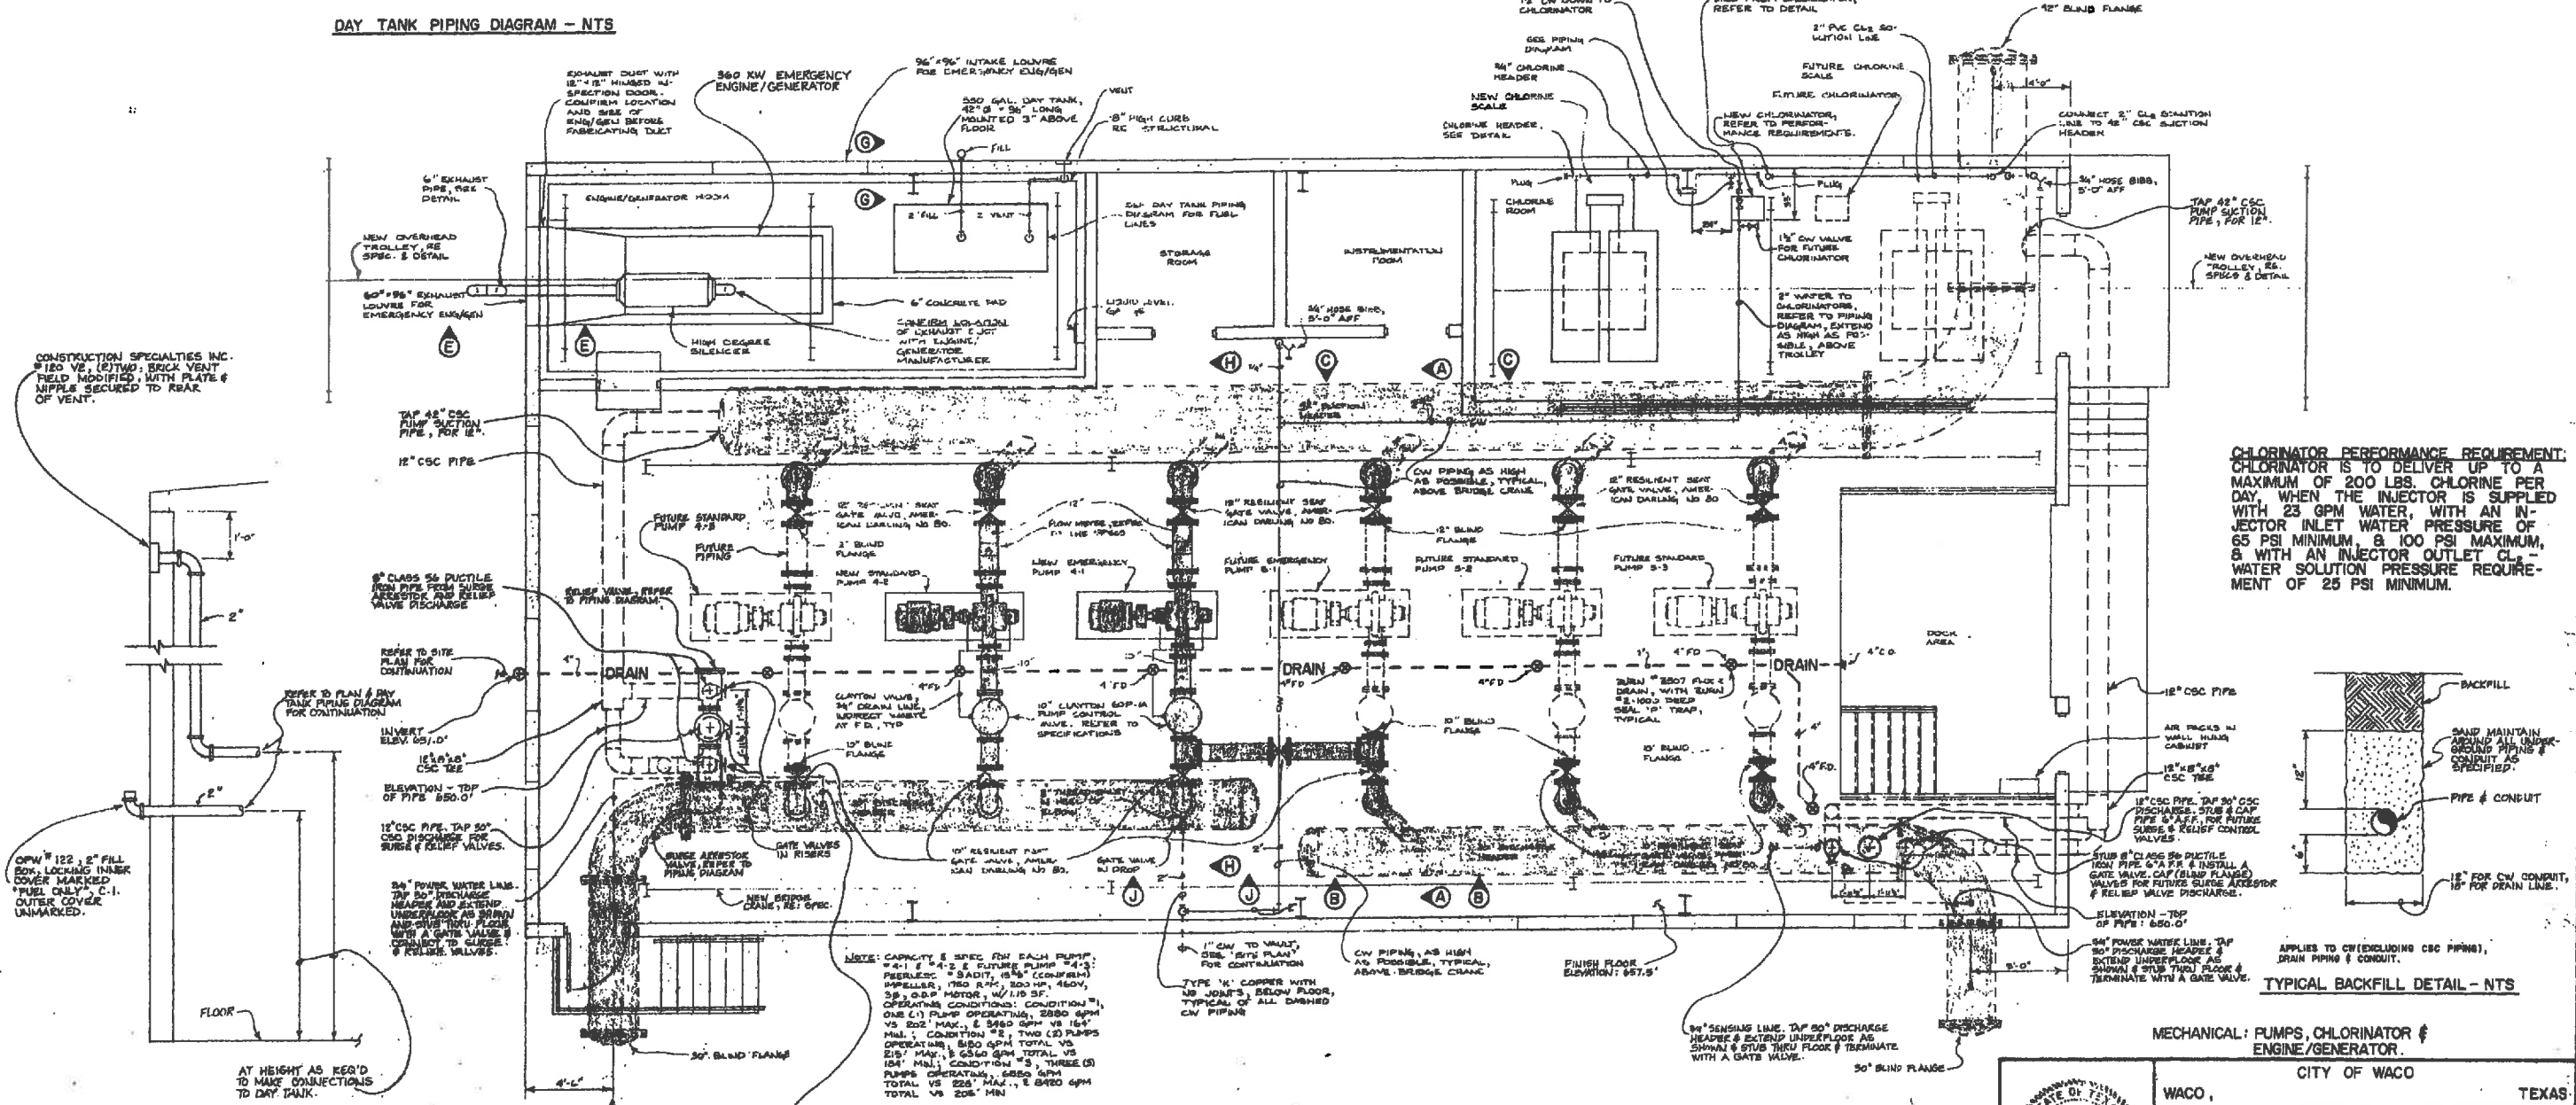


**CHLORINATOR PERFORMANCE REQUIREMENT:**  
 CHLORINATOR IS TO DELIVER UP TO A MAXIMUM OF 200 LBS. CHLORINE PER DAY, WHEN THE INJECTOR IS SUPPLIED WITH 23 GPM WATER, WITH AN INJECTOR INLET WATER PRESSURE OF 65 PSI MINIMUM, 800 PSI MAXIMUM, & WITH AN INJECTOR OUTLET CL<sub>2</sub> WATER SOLUTION PRESSURE REQUIREMENT OF 25 PSI MINIMUM.

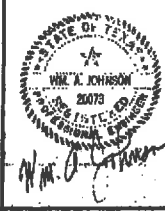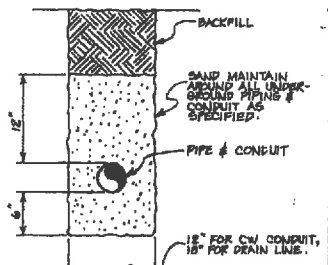

CITY OF WACO, TEXAS		
WACO, TEXAS	DATE: FEB. 18, 1986	SCALE: AS SHOWN
DRN: EE & NM	CHG: CD: WAJ	
WM. A. JOHNSON - CONSULTING ENGINEER		
WACO, TEXAS		
OLD McGREGOR ROAD		
PUMP STATION		
SHEET: ME2 OF 4		

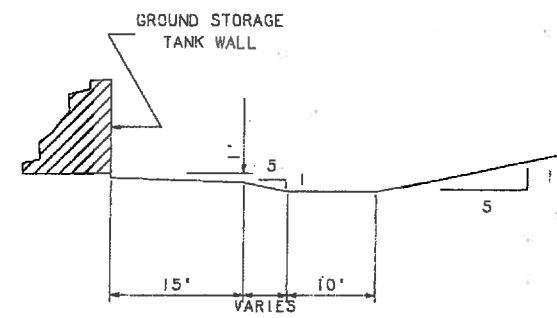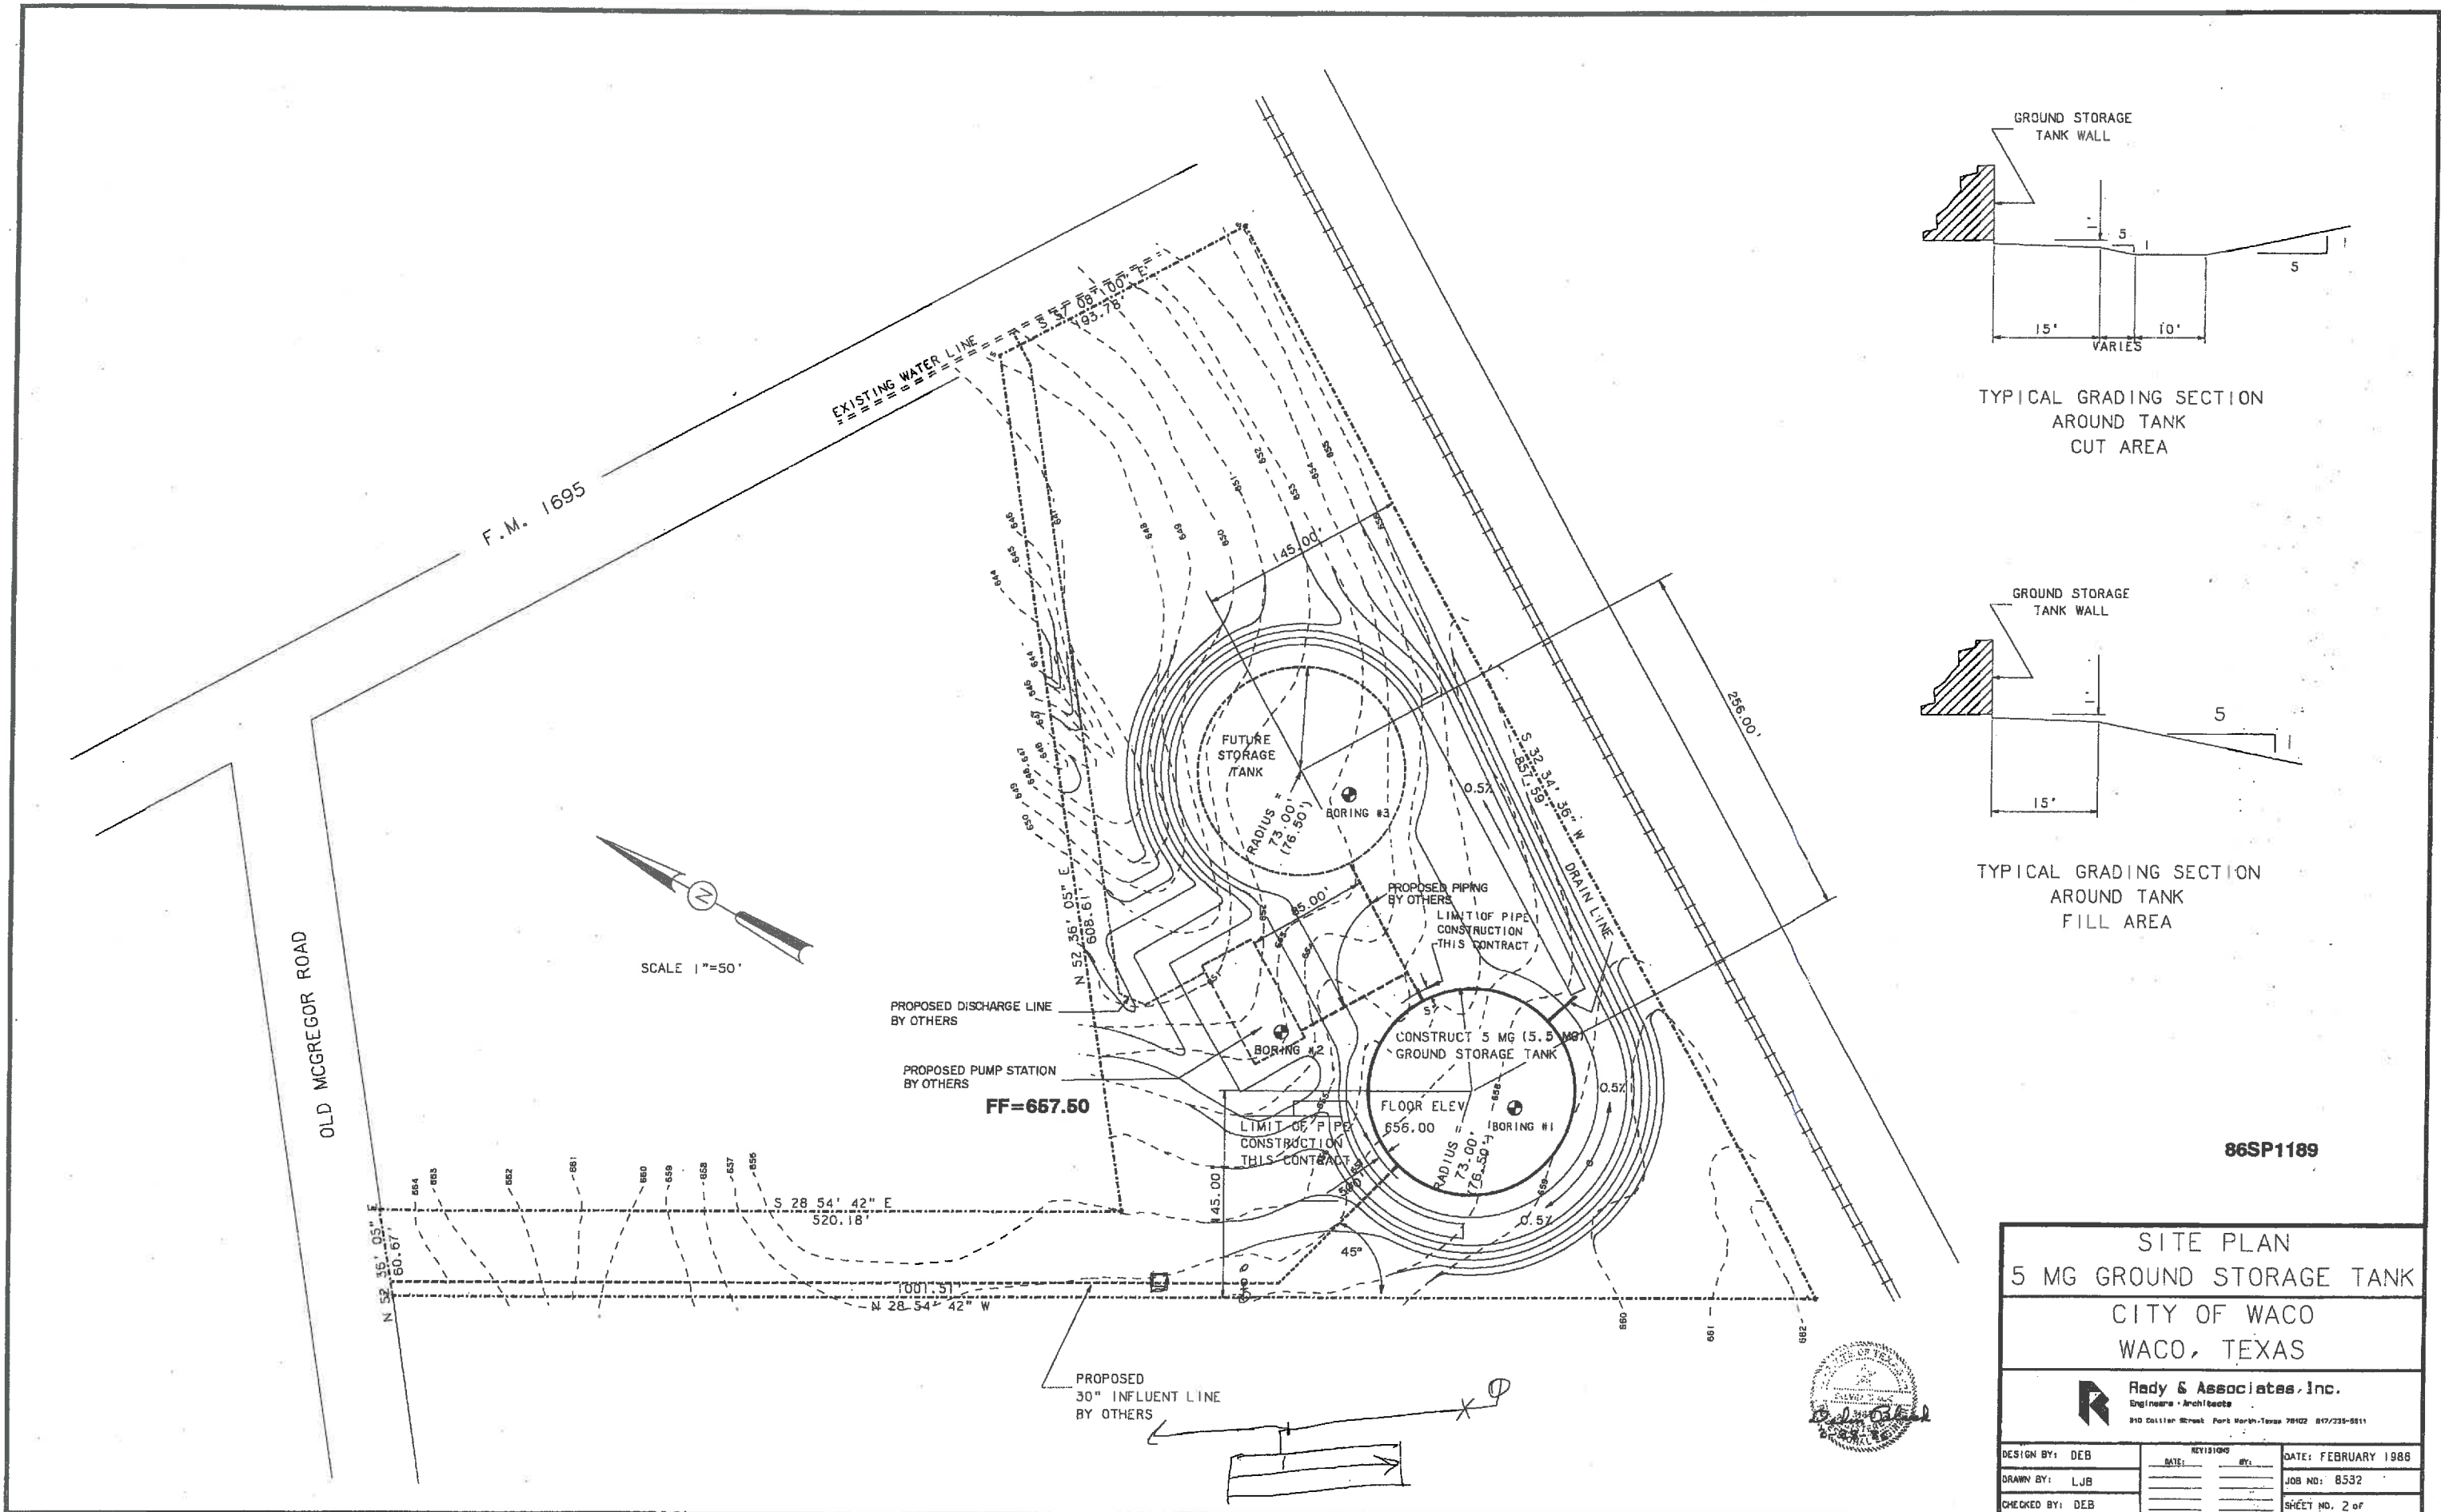

TYPICAL GRADING SECTION  
AROUND TANK  
CUT AREA

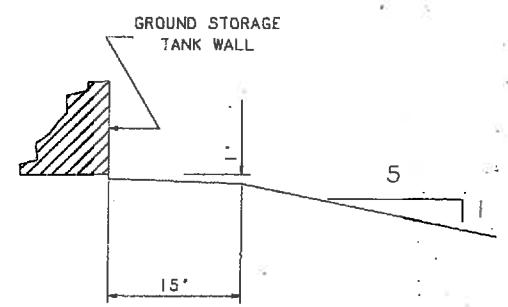

TYPICAL GRADING SECTION  
AROUND TANK  
FILL AREA

86SP1189

SITE PLAN  
5 MG GROUND STORAGE TANK  
CITY OF WACO  
WACO, TEXAS

**Rady & Associates, Inc.**  
Engineers - Architects  
810 Collier Street, Park North, Texas 76702 817/239-8811

DESIGN BY: DEB	DATE: _____	DATE: FEBRUARY 1986
DRAWN BY: LJB	REVISIONS:	JOB NO: 8532
CHECKED BY: DEB	BY: _____	SHEET NO. 2 of _____